ALLEGAN COUNTY ROAD COMMISSION


46TH STREET CULVERT REPLACEMENT PROJECT 170' SOUTH OF 143RD AVENUE **OVERISEL TOWNSHIP**

EXCEPT WHERE OTHERWISE INDICATED ON THESE PLANS OR IN THE PROPOSAL AND SUPPLEMENTAL SPECIFICATIONS CONTAINED THEREIN, ALL MATERIALS AND WORKMANSHIP SHALL BE IN ACCORDANCE WITH THE 2012 MICHIGAN DEPARTMENT OF TRANSPORTATION STANDARD SPECIFICATIONS FOR CONSTRUCTION.

THE PLACING OF PAVEMENT MARKINGS AND TRAFFIC CONTROL SIGNS SHALL BE DONE IN ACCORDANCE WITH THE 2011 MICHIGAN MANUAL OF UNIFORM TRAFFIC CONTROL

AMERICAN ASSOCIATION OF STATE HIGHWAY AND TRANSPORTATION OFFICIALS, 2011 EDITION; A POLICY ON GEOMETRIC DESIGN OF HIGHWAYS AND STREETS.

THE CONTRACTOR SHALL DIAL MISS DIG @ 811 FOR PROTECTION OF UNDER GROUND UTILITIES AND IN CONFORMANCE WITH PUBLIC ACT 174 OF 2013 A MINIMUM OF THREE FULL WORKING DAYS, EXCLUDING SATURDAYS, SUNDAYS AND HOLIDAYS PRIOR TO BEGINNING EACH EXCAVATION IN AREAS WHERE PUBLIC UTILITIES HAVE NOT BEEN PREVIOUSLY LOCATED. MEMBERS WILL THUS BE ROUTINELY NOTIFIED. THIS DOES NOT RELIEVE THE CONTRACTOR OF THE RESPONSIBILITY OF NOTIFYING UTILITY OWNERS WHO MAY NOT BE A PART OF THE "MISS DIG" ALERT SYSTEM.

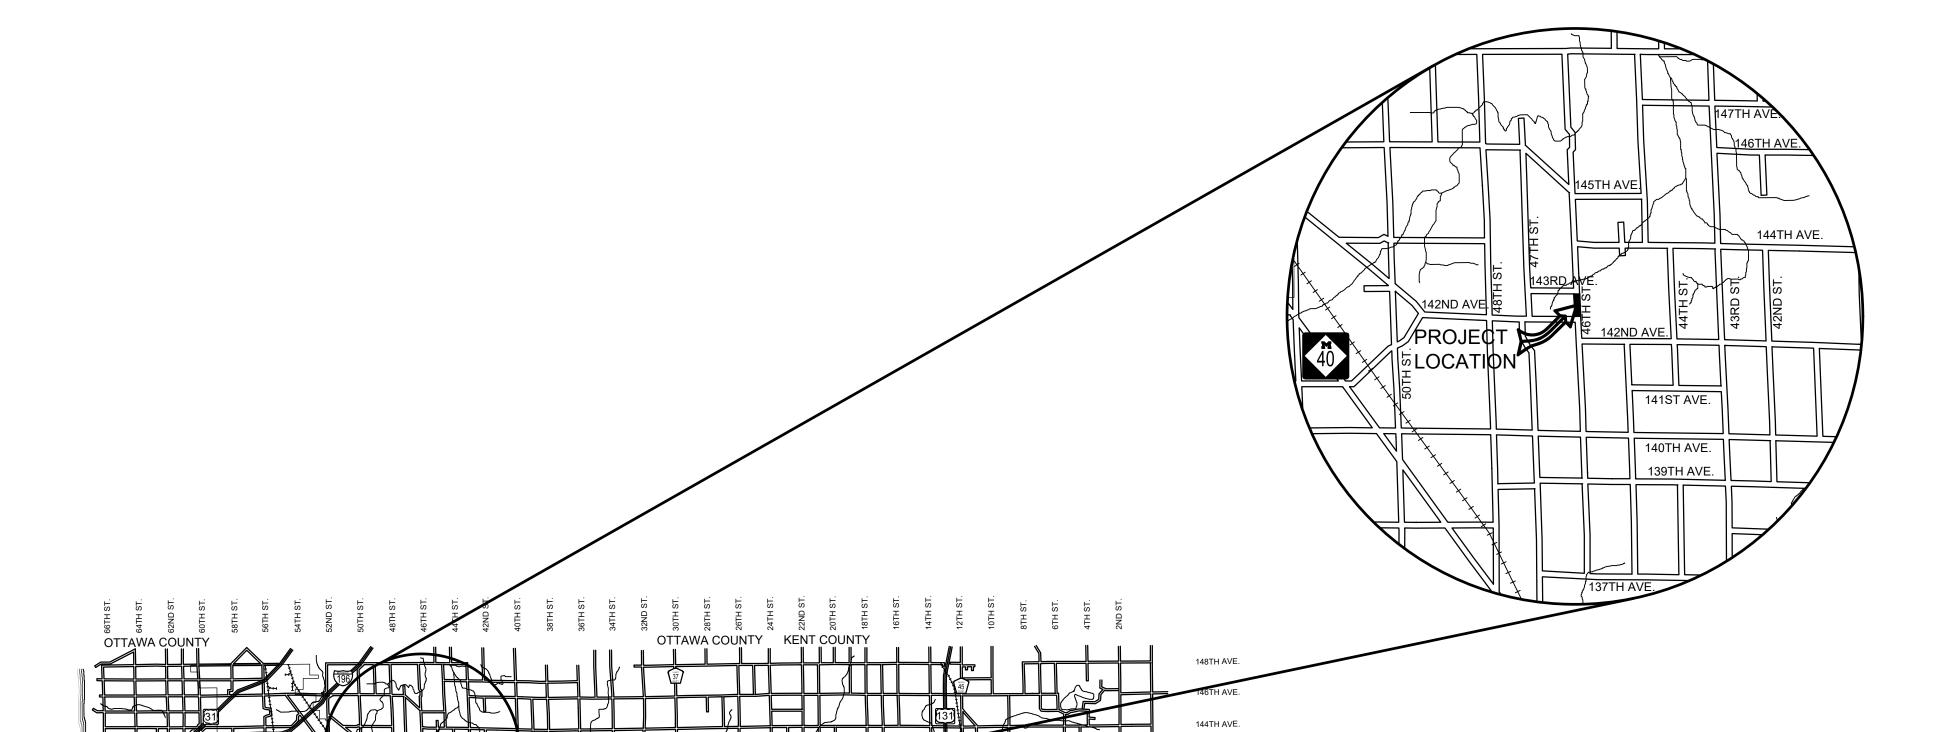

UTILITY CONTACTS

ELECTRIC CONSUMERS ENERGY 4000 CLAY AVE, SW MS. KYLEE MAYCROFT

739 PAW PAW DRIVE HOLLAND, MI 49422 800-476-1441 EXT. 5788 MR. GREG STROH grcivimp@cmsenergy.com greg.stroh@semcoenergy.com

"MISS DIG" 811


601 N. US 131 THREE RIVERS, MI 49093 269-273-0383 MR. JEREMY MCCORD jeremy.mccord@ftr.com CABLE CHARTER

4176 COMMERCIAL AVE PORTAGE, MI 49002 269-217-8152 MR. LEO SCOFIELD leo.scofield@charter.com

GAS CONSUMERS ENERGY 2500 E CORK ST KALAMAZOO, MI 49001 269-337-2366 MR. KYLE OAK kyle.oak@cmsenergy.com

CONTRACT FOR ROAD IMPROVEMENTS

CULVERT REPLACEMENT INCLUDING GRADE ESTABLISHMENT, SAND SUBBASE AGGREGATE BASE, HMA PAVING (0.28 MILES), GRAVEL SHOULDERS, PAVEMENT MARKINGS, AND RESTORATION ON 46TH STREET APPROXIMATELY 170 FEET SOUTH OF 143RD AVENUE IN OVERISEL TOWNSHIP, ALLEGAN COUNTY.

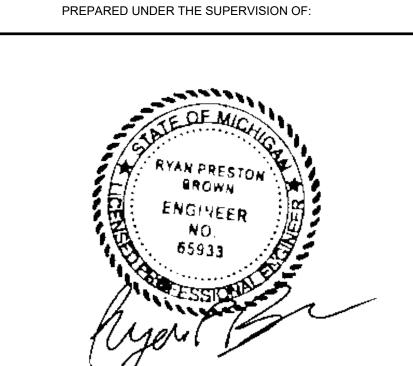

RYAN P. BROWN REGISTERED PROFESSIONAL ENGINEER No. 65933

DRAWN BY: REVIEWED BY: SCALE:

VE

RE TOV


SES


O 00 1

LH 4954

INDEX OF PLANS

- 1 COVER SHEET 2 - TYPICAL SECTIONS, DETAILS, & NOTES
- 3 PLAN & PROFILE AND SOIL EROSION & SEDIMENTATION CONTROL PLAN
- 4 DETOUR ROUTES

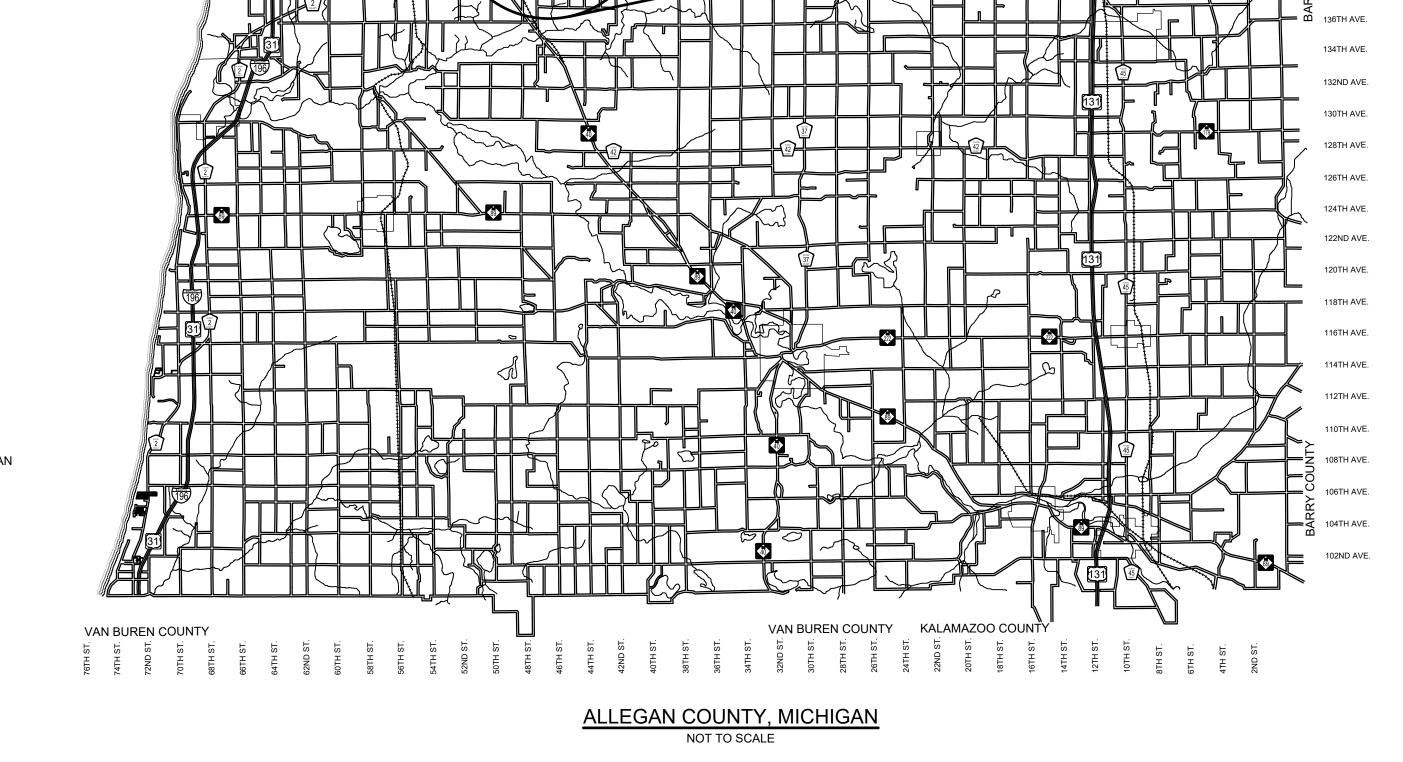

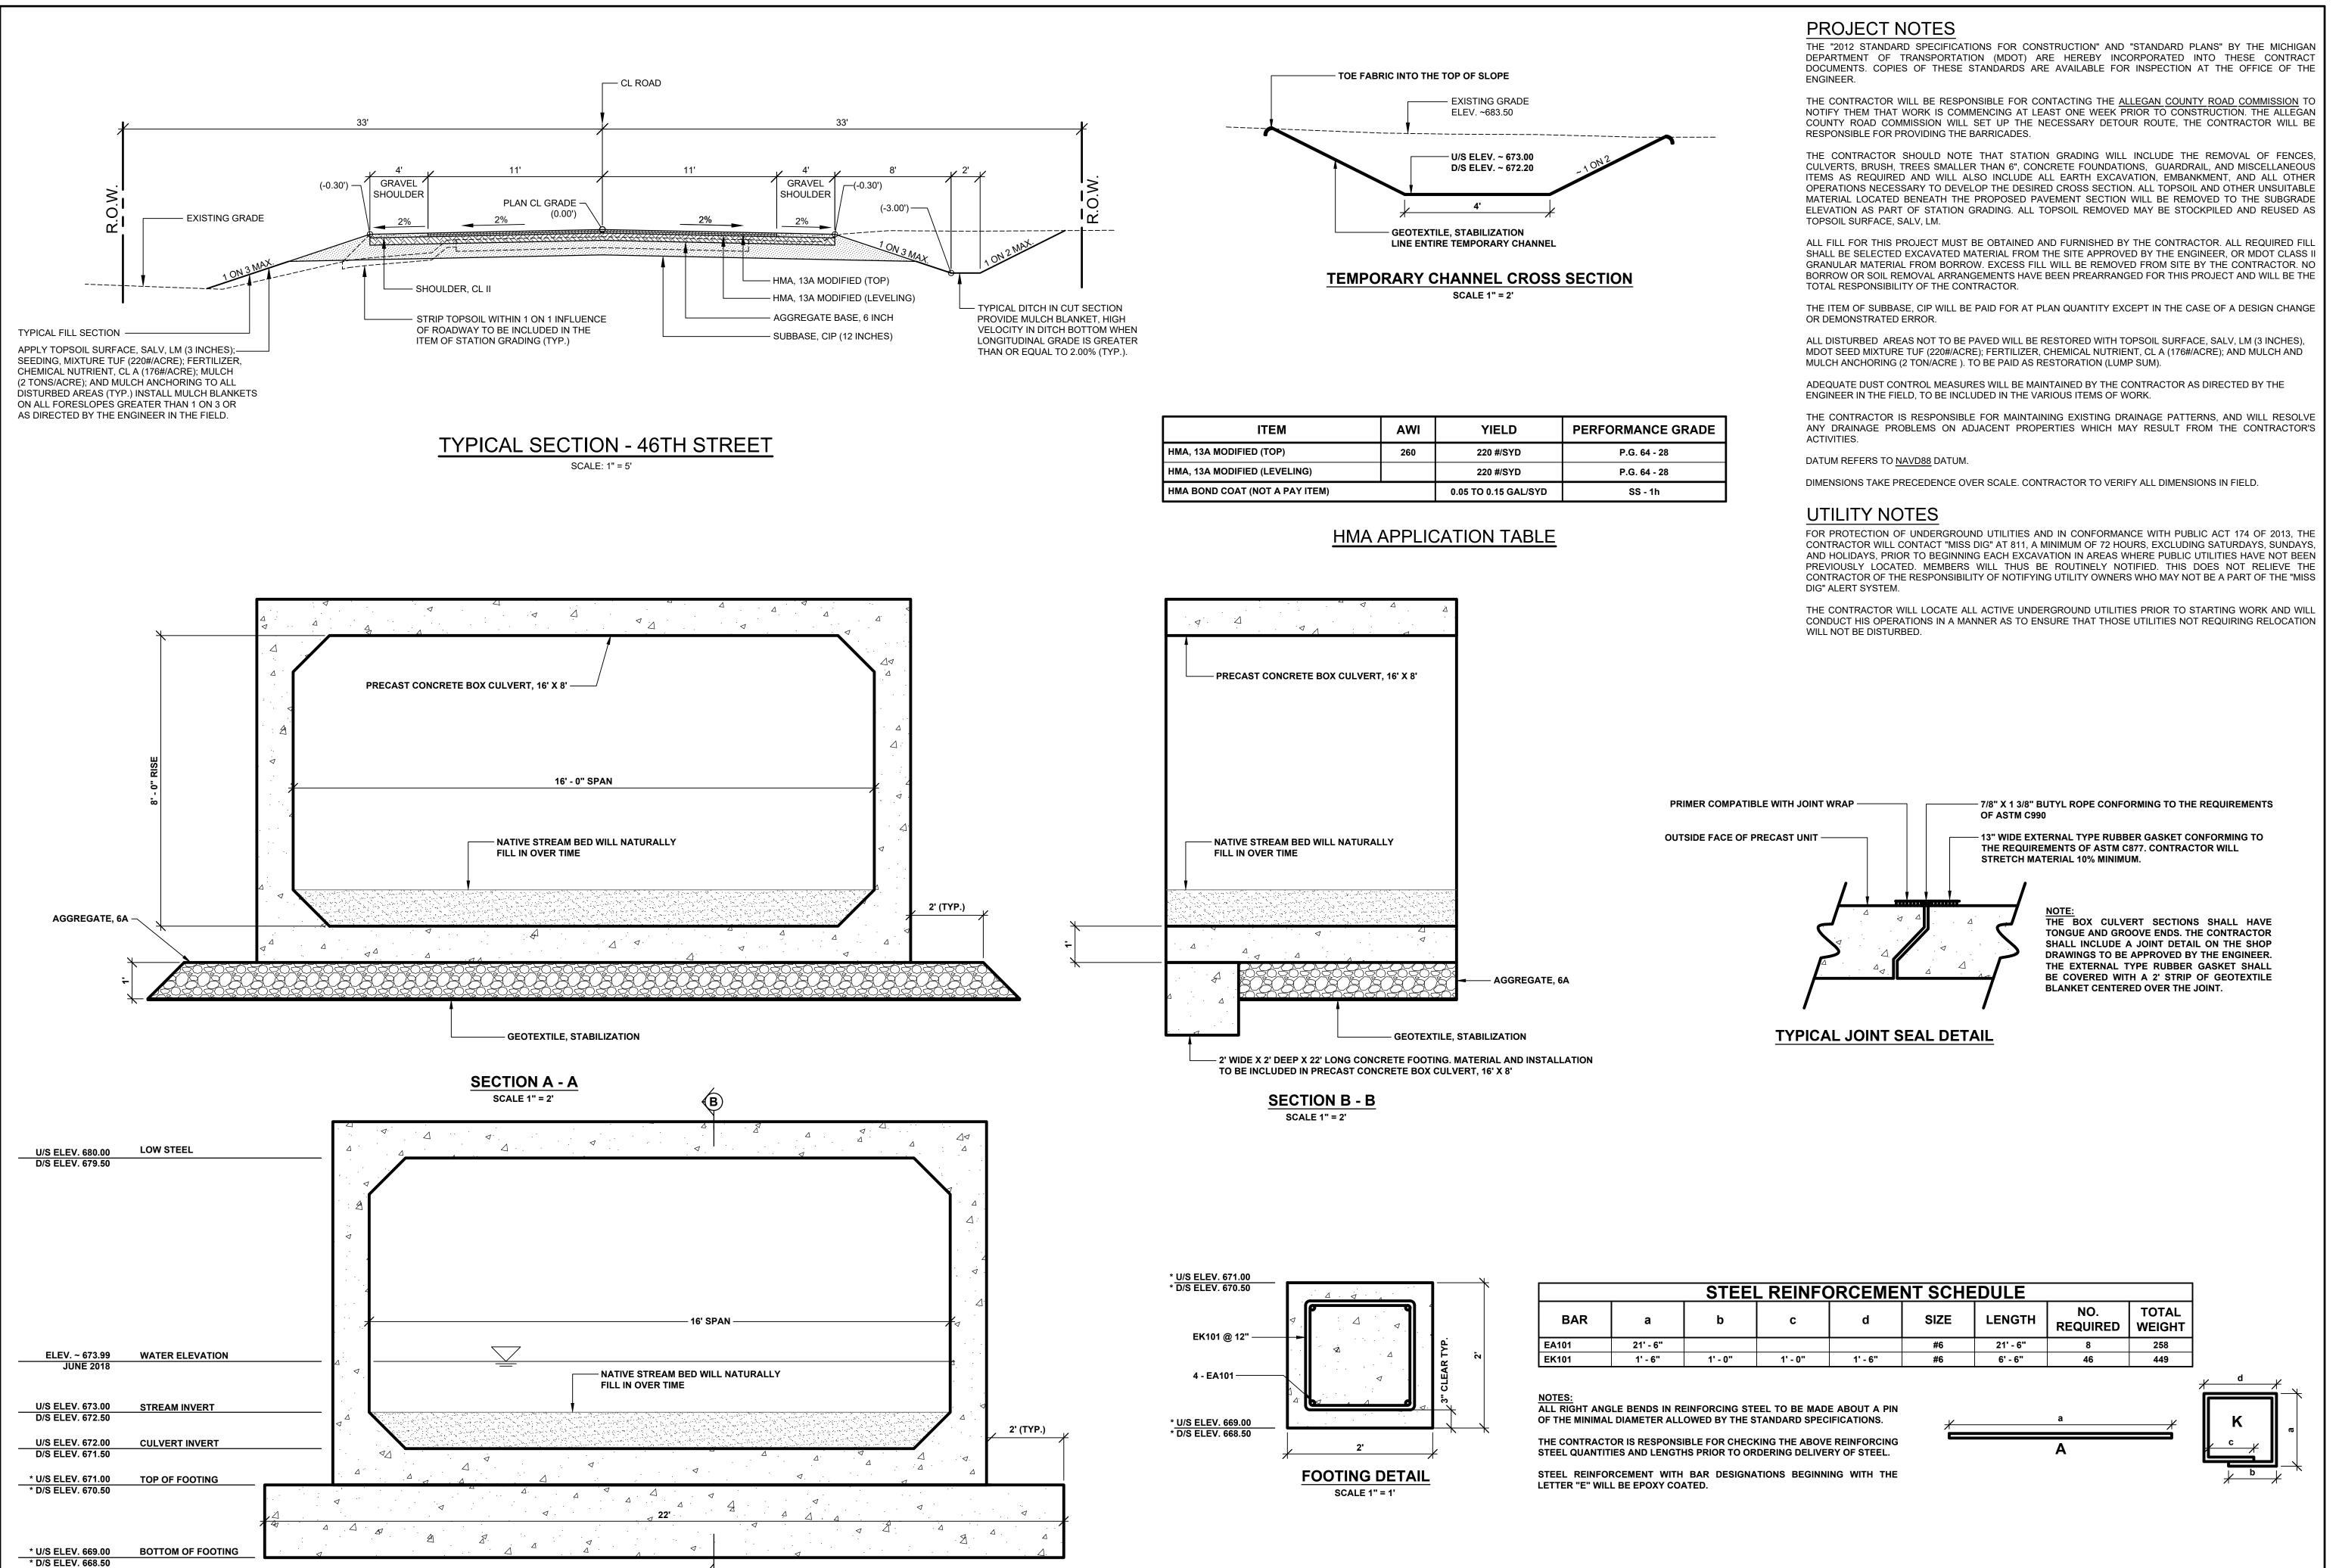

INVERT ELEVATION OF BOX CULVERT GOVERNS. TOP OF FOOTING &

BOTTOM OF FOOTING ELEVATIONS MAY VARY BASED UPON THE MANUFACTURER'S CULVERT DESIGN. CONTRACTOR IS RESPONSIBLE

FOR ADJUSTING THE FOOTING ACCORDINGLY.

TYPICAL INLET AND OUTLET SECTION

SCALE 1" = 2'

- 2 E 4 G 0 L

Common

っつ

unty Road Allegan

В


DRAWN BY: REVIEWED BY:

Ò @ '

R

JANUARY, 2019 SCALE: AS NOTED

LH 4954

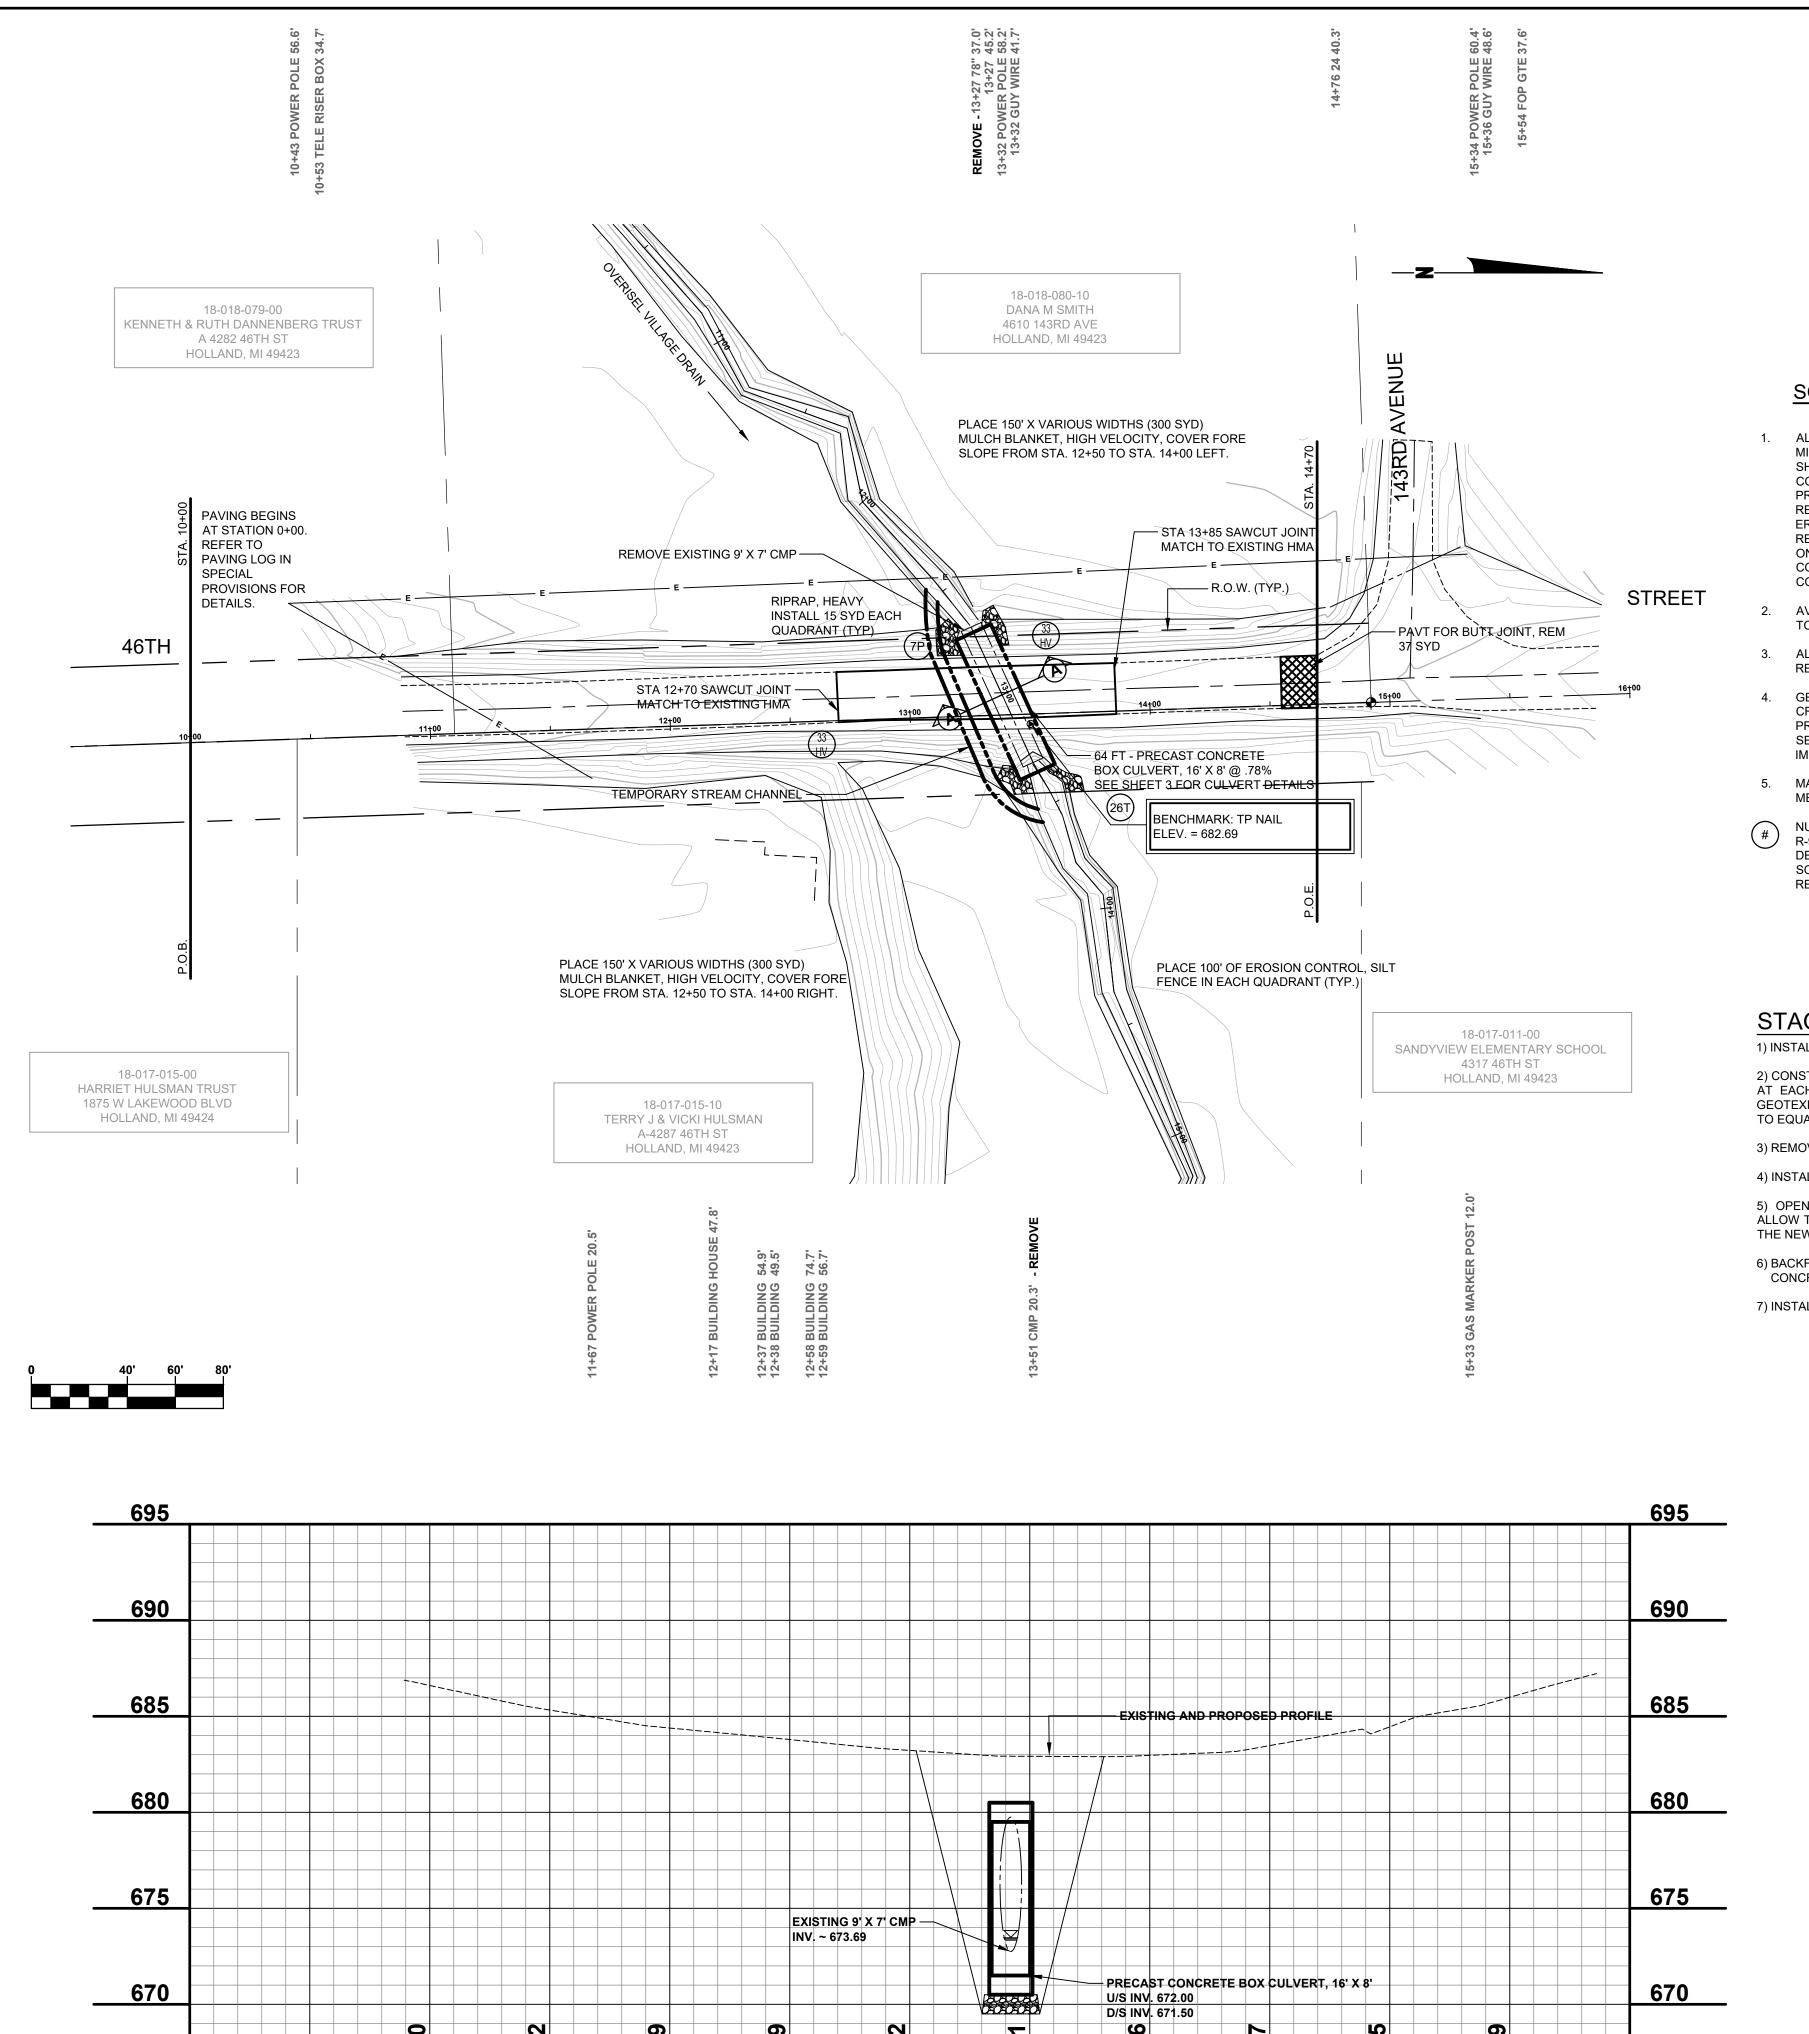

13+00

11+00

12+00

SOIL EROSION & SEDIMENTATION CONTROL NOTES

- 1. ALL CONSTRUCTION METHODS SHALL BE DONE IN COMPLIANCE WITH THE MICHIGAN SOIL EROSION AND SEDIMENTATION CONTROL ACT. THE OWNER SHALL BE RESPONSIBLE FOR OBTAINING A "SOIL EROSION PERMIT" FROM THE COUNTY AND A "PERMIT BY RULE/NOTICE OF COVERAGE" FROM THE MDEQ PRIOR TO START OF CONSTRUCTION. THE CONTRACTOR SHALL BE RESPONSIBLE FOR COMPLYING WITH ALL REQUIREMENTS OF THE COUNTY "SOIL EROSION PERMIT" AND FOR ALL CERTIFIED STORM WATER INSPECTION SERVICE REQUIRED BY THE "PERMIT BY RULE." EROSION CONTROL MEASURES SHOWN ON THE PLANS ARE THE MINIMUM REQUIREMENTS AND SHALL NOT RELIEVE THE CONTRACTOR'S RESPONSIBILITY FOR PROVIDING ALL REQUIRED EROSION CONTROL MEASURES.
- AVOID UNNECESSARY DISTURBING OR REMOVING OF EXISTING VEGETATED TOPSOIL OR EARTH COVER, THESE COVER AREAS ACT AS SEDIMENT FILTERS.
- 3. ALL TEMPORARY SOIL EROSION PROTECTION SHALL REMAIN IN PLACE UNTIL REMOVAL IS REQUIRED FOR FINAL CLEAN UP AND APPROVAL.
- GEOTEXTILE SILT FENCE SHALL BE INSTALLED AS REQUIRED WHEN CROSSING CREEKS OR WHEN ADJACENT TO WETLANDS OR SURFACE WATER BODIES TO PREVENT SILTATION AND ELSEWHERE AS DIRECTED BY THE ENGINEER. SEEDING AND/OR SODDING SHALL BE INSTALLED ON CREEK BANKS IMMEDIATELY AFTER CONSTRUCTION TO PREVENT EROSION.
- 5. MAINTENANCE, CLEANING, AND REMOVAL OF THE VARIOUS SEDIMENT CONTROL MEASURES SHALL BE INCLUDED IN THE VARIOUS EROSION CONTROL ITEMS.
- NUMBER IN CIRCLE REFERS TO NUMBERED DETAILS ON MDOT STANDARD PLAN R-96 SERIES, SOIL EROSION & SEDIMENTATION CONTROL MEASURES. "P" DENOTES PERMANENT MEASURE AND "T" DENOTES TEMPORARY MEASURE. SOIL EROSION CONTROL PLANS DENOTE MINIMUM EROSION MEASURES REQUIRED AS DESCRIBED BELOW.

- ALL DISTURBED AREAS NOT PAVED OR GRAVELED SHALL BE PAY ITEM INCLUDES PLACING MOOT SEEDING, MIXTURE TUF APPLIED RESTORED UNDER THE PAY ITEM RESTORATION (LUMP SUM). THIS AT A RATE OF 220 LB/ACRE, FERTILIZER, CHEMICAL NUTRIENT, CL A APPLIED AT A RATE OF 176 LB/ACRE; MULCH AT A RATE OF 2 TON/ACRE AND MULCH ANCHORING.
- TEMPORARY SEEDING WILL BE PLACED AT LOCATIONS DETERMINED BY THE ENGINEER IN THE FIELD AND WILL INCLUDE SEEDING MIXTURE, CR APPLIED AT A RATE OF 70 LB/ACRE AND MULCH.
- DUST CONTROL MAY BE REQUIRED ON THE SUBGRADE CONSTRUCTION AND WILL INCLUDE APPLYING FRESH WATER TO BE INCLUDED IN THE ITEM OF EMBANKMENT. DUST CONTROL ON THE AGGREGATE BASE COURSE WILL BE ACCOMPLISHED BY APPLYING FRESH WATER (INCLUDED IN THE ITEM OF AGGREGATE BASE, 6 INCH) AS DIRECTED BY THE PROJECT ENGINEER.
- INSTALL RIPRAP, HEAVY AS DIRECTED BY THE ENGINEER IN THE FIELD. THE RIPRAP, HEAVY AS DIRECTED BY THE ENGINEER IN THE RIPRAP, HEAVY PAY ITEM WILL INCLUDE A GEOTEXTILE UNDERLAYMENT.
- SILT FENCE WILL BE INSTALLED AT CREEK CROSSINGS, ADJACENT TO ALL WETLANDS AND SURFACE WATERS, AND OTHER LOCATIONS AS DIRECTED BY THE ENGINEER. EACH SILT FENCE WILL BE INSTALLED GENERALLY ALONG THE SAME CONTOUR ELEVATION.
- HIGH VELOCITY MULCH BLANKETS WILL BE USED ON STEEP BANKS. PROVIDE MULCH BLANKET, HIGH VELOCITY CENTERED ON ALL DITCH BOTTOMS WITH A LONGITUDINAL GRADE OF 2.00% OR GREATER AND AT OTHER LOCATIONS AS DIRECTED BY THE ENGINEER IN THE FIELD.

STAGING NOTES

665

1) INSTALL TEMPORARY EROSION CONTROL MEASURES.

2) CONSTRUCT THE TEMPORARY CHANNEL WITH A 6A STONE PILE AT EACH END AS A PLUG. AFTER LINING THE CHANNEL WITH GEOTEXITLE, OPEN THE DOWNSTREAM PLUG, ALLOW THE WATER TO EQUALIZE, AND THEN REMOVE THE UPSTREAM PLUG.


3) REMOVE THE EXISTING 9' X 7' CMP CULVERT.

4) INSTALL THE 16' X 8' PRECAST CONCRETE BOX CULVERT.

5) OPEN THE CHANNEL FROM THE DOWN STREAM END AND ALLOW THE WATER TO EQUALIZE. OPEN THE UPSTREAM SIDE OF THE NEW CHANNEL AND PLUG THE TEMPORARY CHANNEL.

6) BACKFILL THE TEMPORARY CHANNEL AND PRECAST CONCRETE BOX.

7) INSTALL PERMANENT SOIL EROSION CONTROL MEASURES.

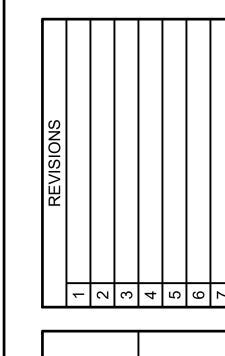


CEME D AVENUE RE S

0 0

DRAWN BY: REVIEWED BY: DATE: JANUARY, 2019 SCALE: 1" = 40'H, 5'\

LH 4954

			LEGEND		
SIGN NO.	QTY.	SIGN DESIGNATION	DESCRIPTION	SIZE	AREA
1	2 EA	W20-1	ROAD WORK AHEAD	48 INCH x 48 INCH	32 SFT
2	3 EA	W20-3	ROAD CLOSED AHEAD	48 INCH x 48 INCH	32 SFT
		D3-2a	46th St	36 INCH x 12 INCH	6 SFT
3	3 EA	W20-2	DETOUR AHEAD	48 INCH x 48 INCH	32 SFT
4	4 EA	M4-9	DETOUR	30 INCH x 24 INCH	15 SFT
		D3-2a	46th St	36 INCH x 12 INCH	9 SFT
(5)	4 EA	M4-9	DETOUR	30 INCH x 24 INCH	15 SFT
		D3-2a	46th St	36 INCH x 12 INCH	9 SFT
6	2 EA	D3-2a	46th St	36 INCH x 12 INCH	6 SFT
		M4-8a	END DETOUR	24 INCH x 18 INCH	6 SFT
7	2 EA	R5-18c	WORK ZONE BEGINS	48 INCH x 48 INCH	32 SFT
8	2 EA	BARRICADE, TYPE III, HIGH INTENSITY, LIGHTED, 2 REQUIRED EACH LOCATION		2 REQUIRED EACH LOCATION	4 EA
		R11-4	ROAD CLOSED TO THRU TRAFFIC	60 INCH x 30 INCH	25 SFT
9	2 EA	G20-2	END ROAD WORK	48 INCH x 24 INCH	16 SFT
				TOTAL AREA =	235 SFT

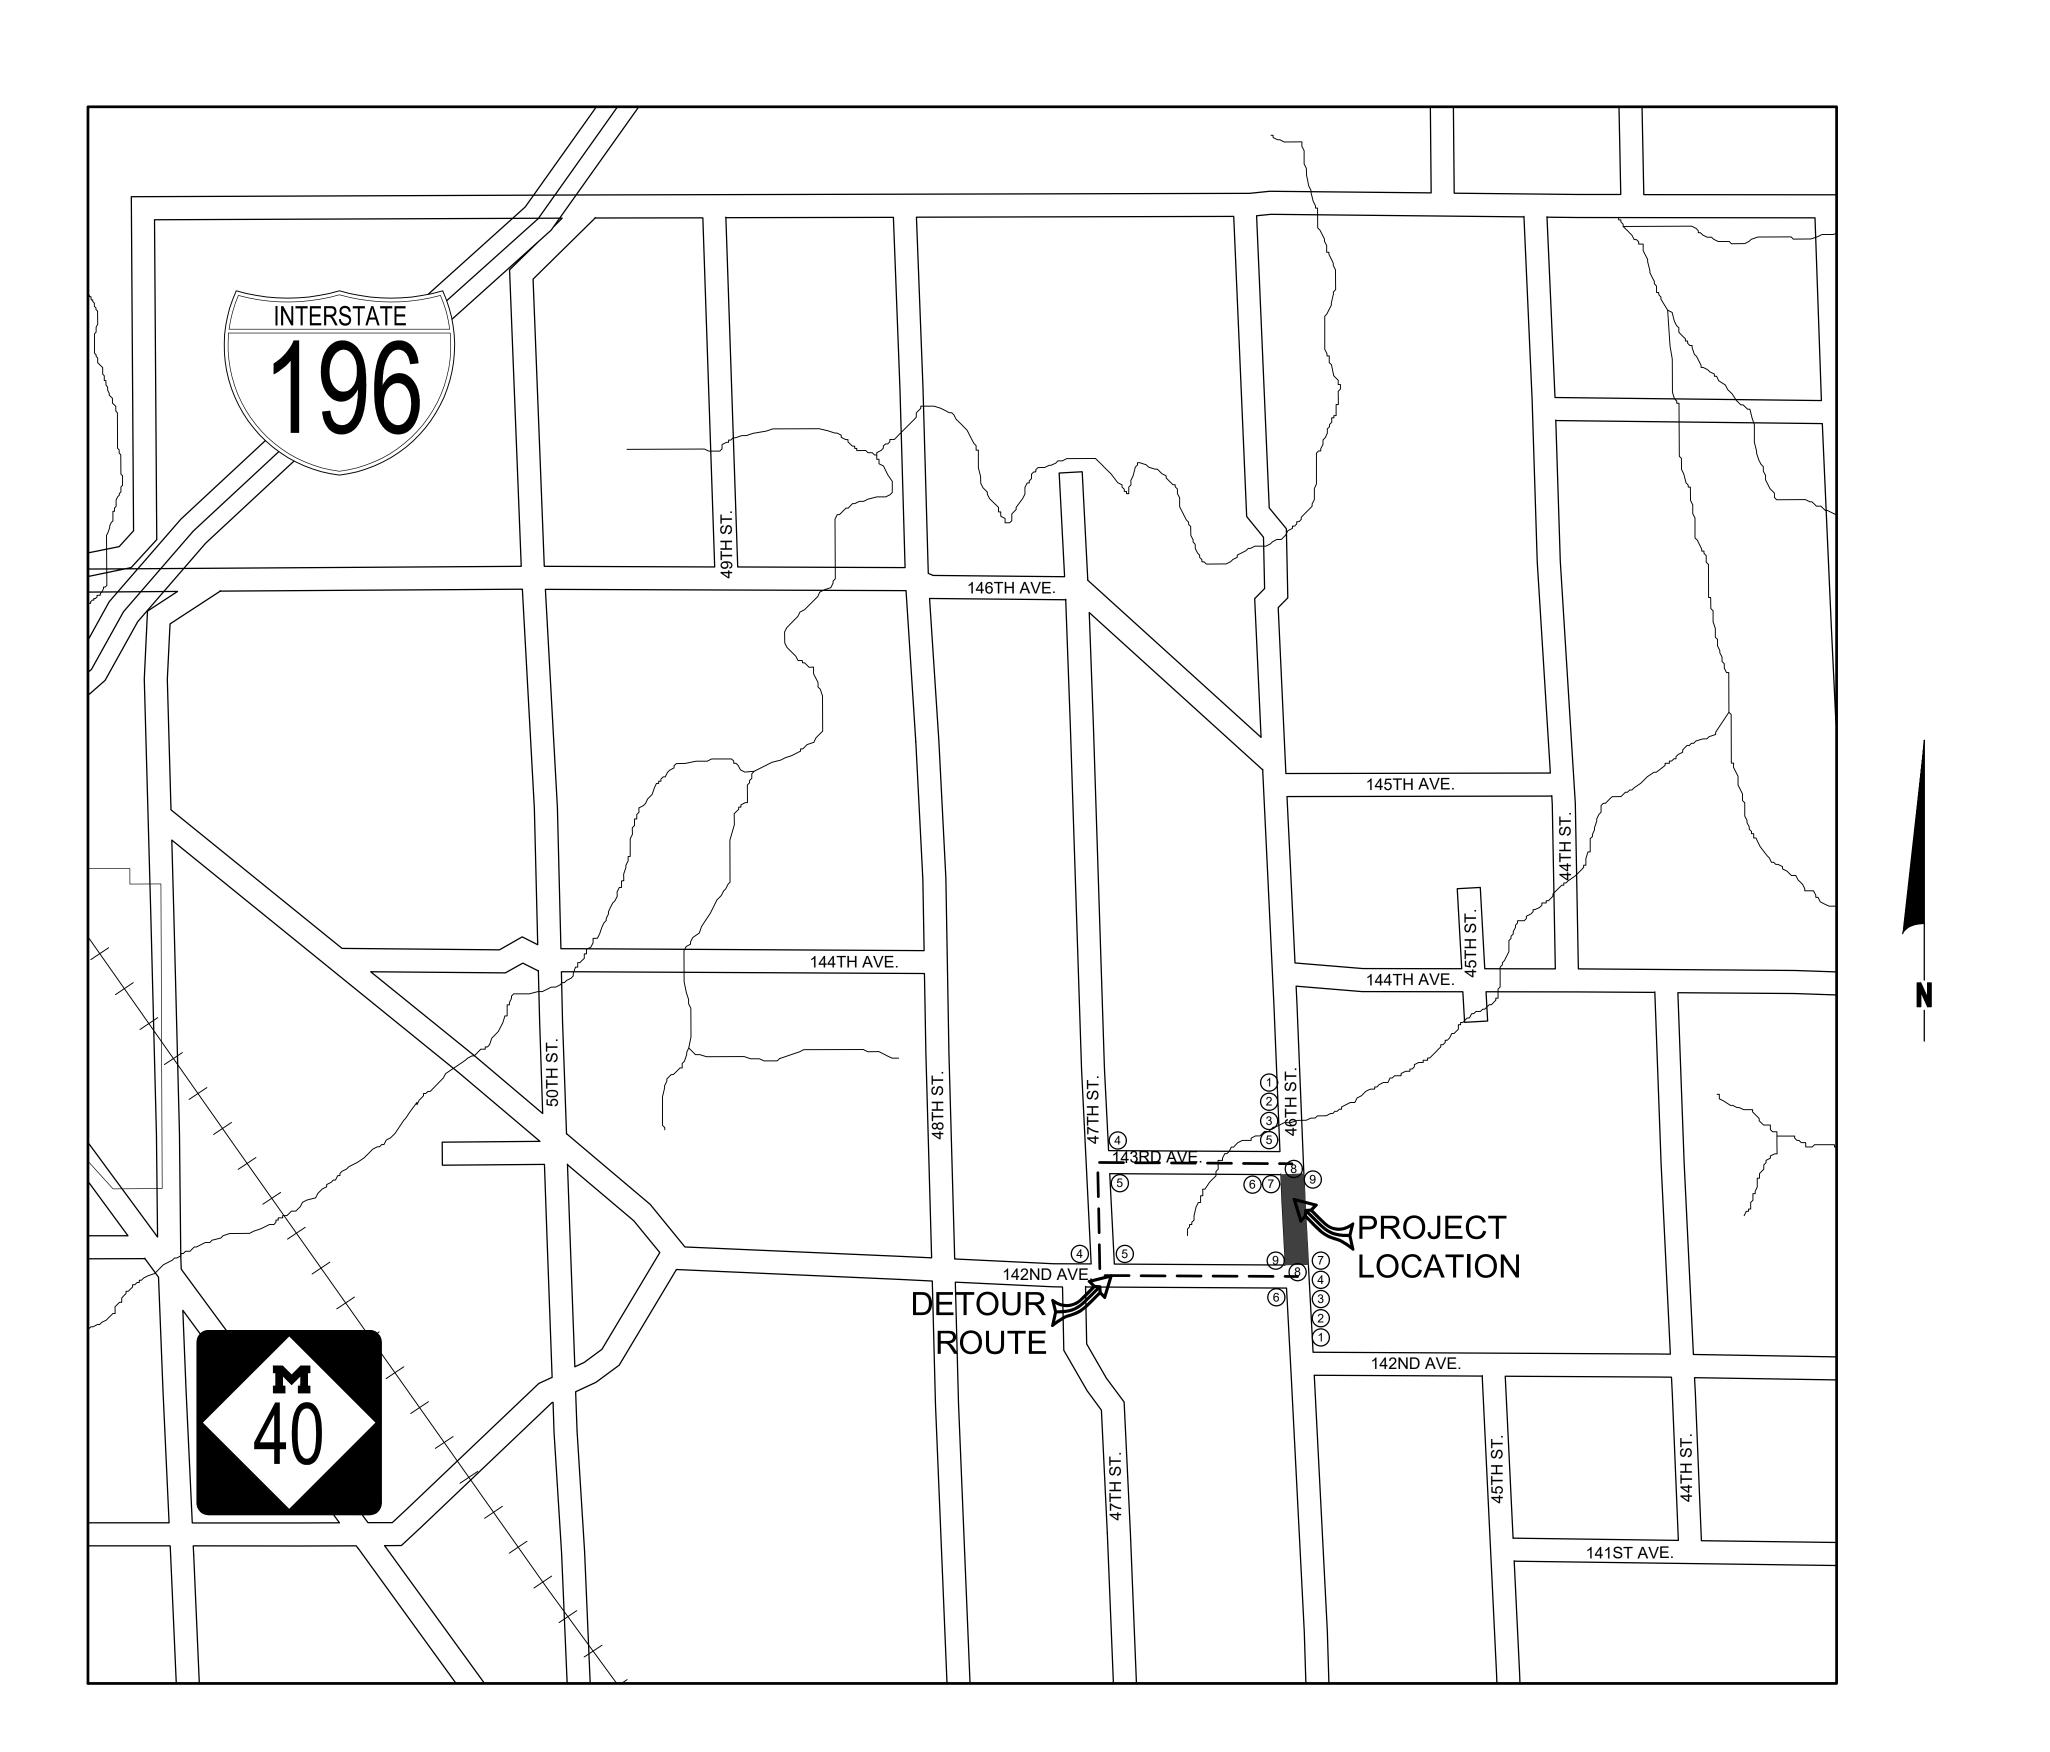

46TH STREET CULVERT REPLACEMENT
SIGNARIAN
OVERISEL TOWNSHIP - 170' SOUTH OF 143RD AVENUE
DETOUR ROUTE

DETOUR ROUTE

A PORTION OF OVERISEL TOWNSHIP

ALLEGAN COUNTY, MI

NOT TO SCALE

SCALE: NONE

LH 4954 4